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Owner/Project

\longrightarrow	NATURAL DRAINAGE CHANNEL
(w)	EXISTING WATERLINE
———— W ————	NEW WATERLINE
(ss)	EXISTING SANITARY SEWER
ss	NEW SANITARY SEWER
———— SD ————	NEW STORM DRAIN

Re	vision		Ву	Appd.	YY.MM.
4	NEW DRAINAGE CALCS		СВ	SB	16.04.2
3	PARK CITY RE-SUBMITTAL		BD	PMD	15.03.2
2	PARK CITY RE-SUBMITTAL		СВ	PMD	15.03.1
1	PARK CITY SUBMITTAL		СВ	JRJ	15.01.2
lss	ued		Ву	Appd.	YY.MM.
⊦il∈	· Name: C-100 sp.dwa	SDJ	JRJ	EKW	14.12.



Client/Project


KING DEVELOPMENT L.L.C. PO BOX 244 PARK CITY, UTAH 84060

ALICE CLAIM

Park City, Utah

Project No.

205303057 Revision Drawing No. Sheet

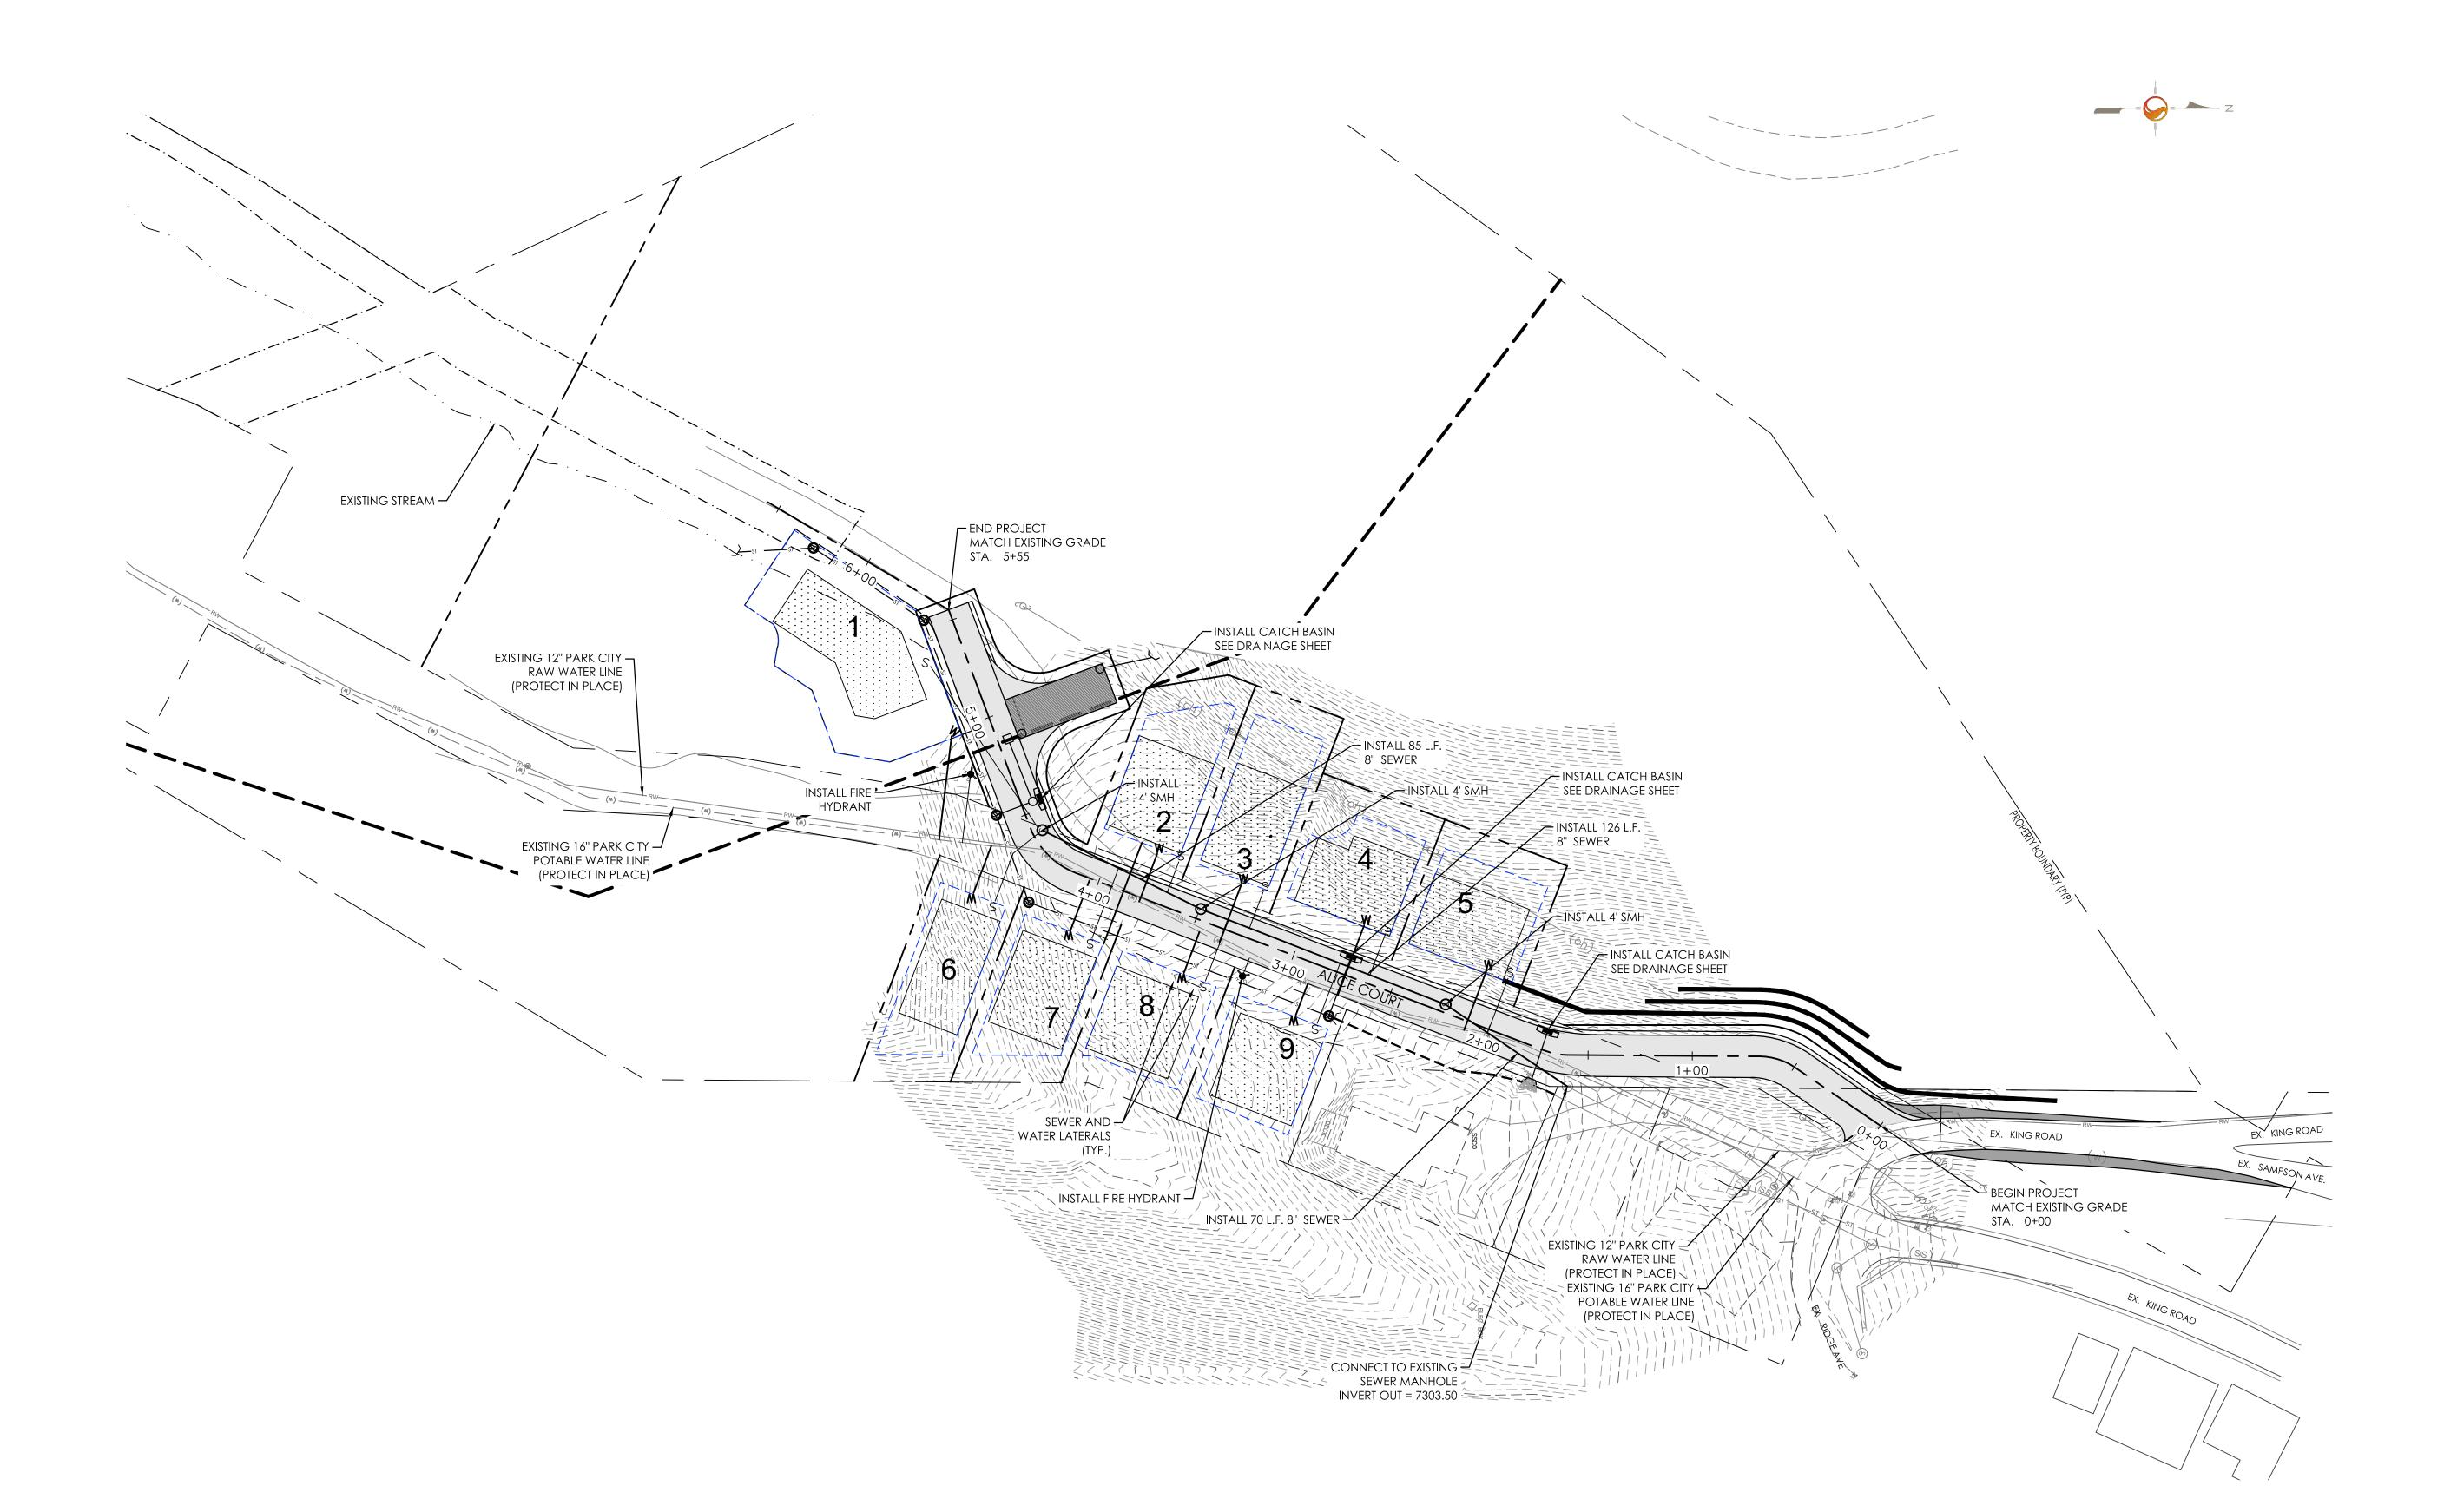



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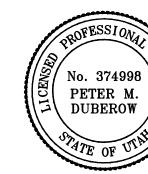
Owner/Project

Lege

NOTES:

1. SANITARY SEWER SHALL BE BUTT FUSED HDPE WHERE SEPARATION FROM WATER IS

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Client/Project

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ALICE CLAIM
Park City, Utah

Title

UTILITY PLAN

Project No.	Scale o 40'	
205303057	1"=40' - 40'	60' 80'
Drawing No.	Sheet	Revision
$\bigcirc \bigcirc \bigcirc \bigcirc \bigcirc$		^





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Owner/Project

LOD	LIMITS OF DISTURBANCE
SF	SILT FENCE (ALT. STRAW WATTLE)
	TEMPORARY RETAINING WALL
	PROPERTY/LOT LINE
4200	EXISTING CONTOUR LINE
4200	FINISH CONTOUR LINE

CLEAN UP AREA DESIGNATION

- TEMPORARY RETAINING WALLS SHALL BE CONSTRUCTED ACROSS FUTURE DRIVEWAYS. FUTURE DRIVEWAYS AND FUTURE RETAINING WALLS N.I.C.
- 2. ALL UTILITY WORK IS FUTURE AND SUBJECT TO REVIEW AND REVISION.

Re	evision	Ву	Appd.	YY.MM.D
4	NEW DRAINAGE CALCS	СВ	SB	16.04.20
3	PARK CITY RE-SUBMITTAL	BD	PMD	15.03.27
2	PARK CITY RE-SUBMITTAL	СВ	PMD	15.03.16
1	PARK CITY SUBMITTAL	СВ	JRJ	15.01.23
ادو	sued	By	Appd.	YY.MM.D

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Client/Project

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ALICE CLAIM
Park City, Utah


Park City,


GRADING PLAN

Project No. 205303057	Scale 0 40'	60' 80'
Drawing No.	Sheet	Revision
C300	of	0

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ORIGINAL SHEET - ARCH D



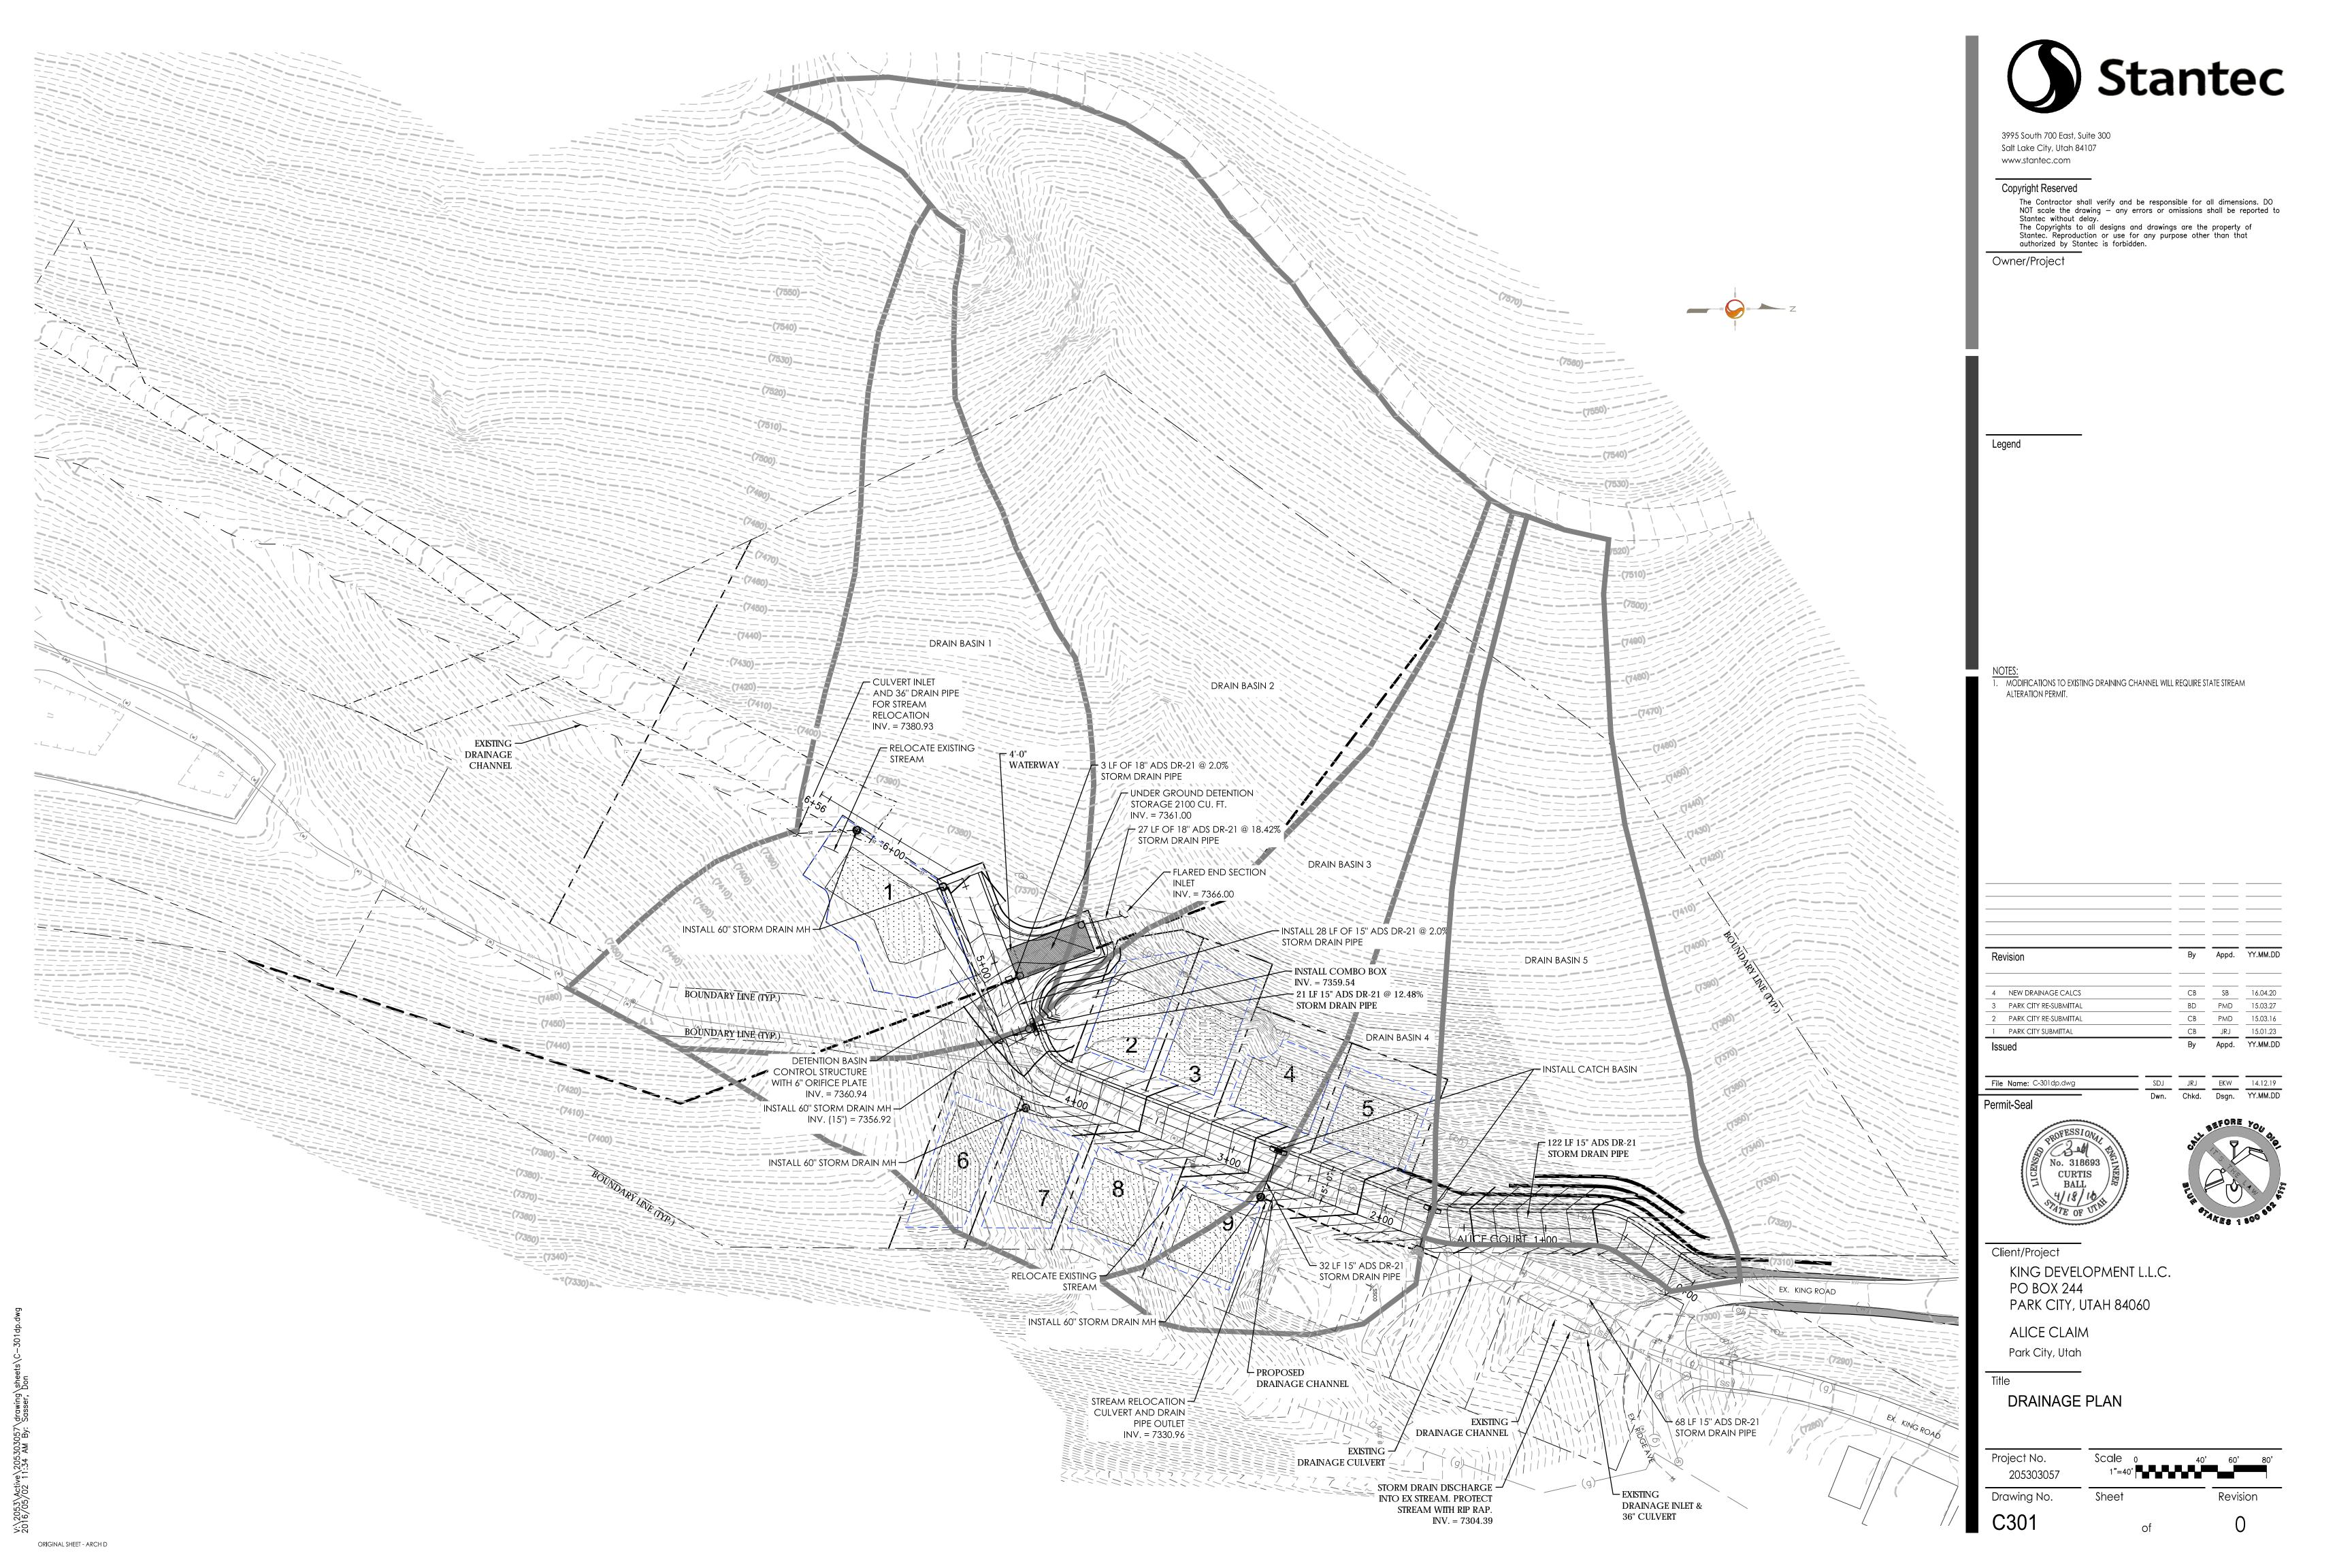

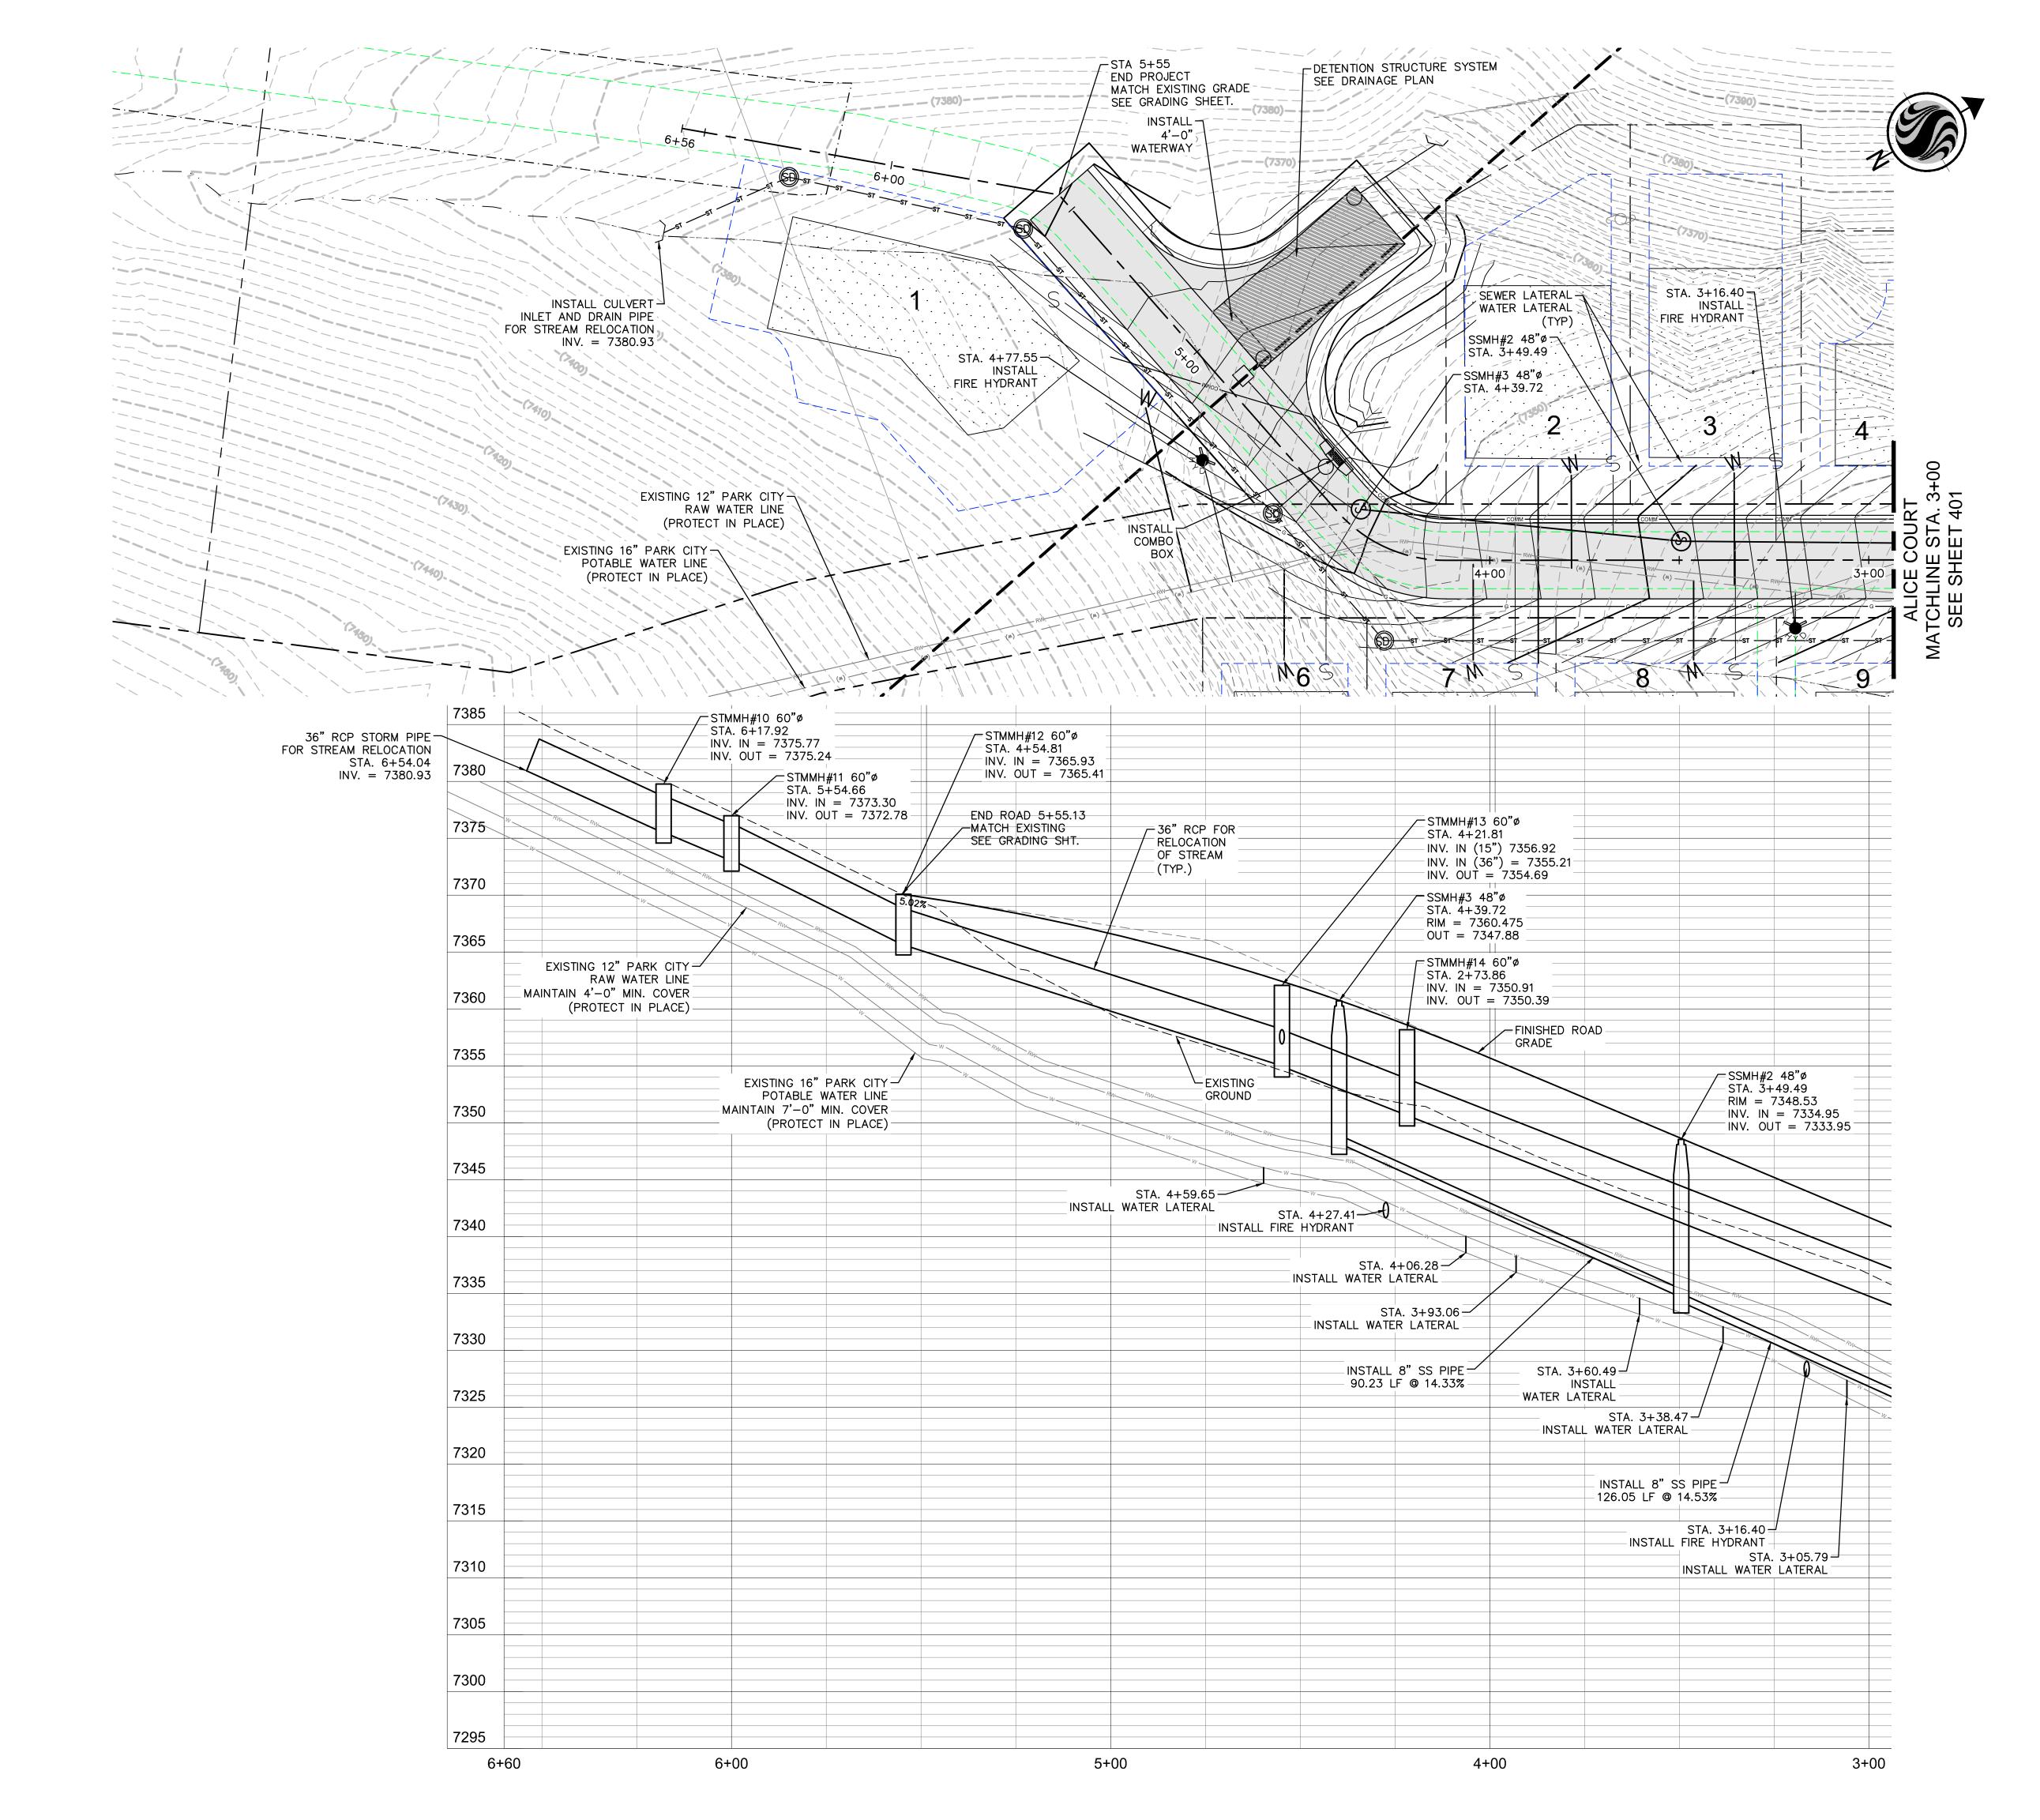

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Owner/Project

Legend


- 1. TEMPORARY RETAINING WALLS SHALL BE CONSTRUCTED ACROSS FUTURE DRIVEWAYS. FUTURE DRIVEWAYS AND FUTURE RETAINING WALLS N.I.C.
- 2. ALL UTILITY WORK IS FUTURE AND SUBJECT TO REVIEW AND REVISION.

By Appd. YY.MM.DD BD PMD 15.03.27 3 PARK CITY RE-SUBMITTAL
 CB
 PMD
 15.03.16

 CB
 JRJ
 15.01.23

 By
 Appd.
 YY.MM.DD
 PARK CITY RE-SUBMITTAL SDJ JRJ EKW 14.12.19
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File Name: C-400 PP-ALICE COURT.dwg

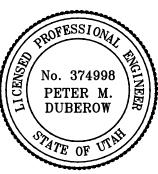

Client/Project


KING DEVELOPMENT L.L.C. PO BOX 244 PARK CITY, UTAH 84060


ALICE CLAIM

Park City, Utah

ALICE GULCH PLAN AND PROFILE

205303057 Drawing No. C400

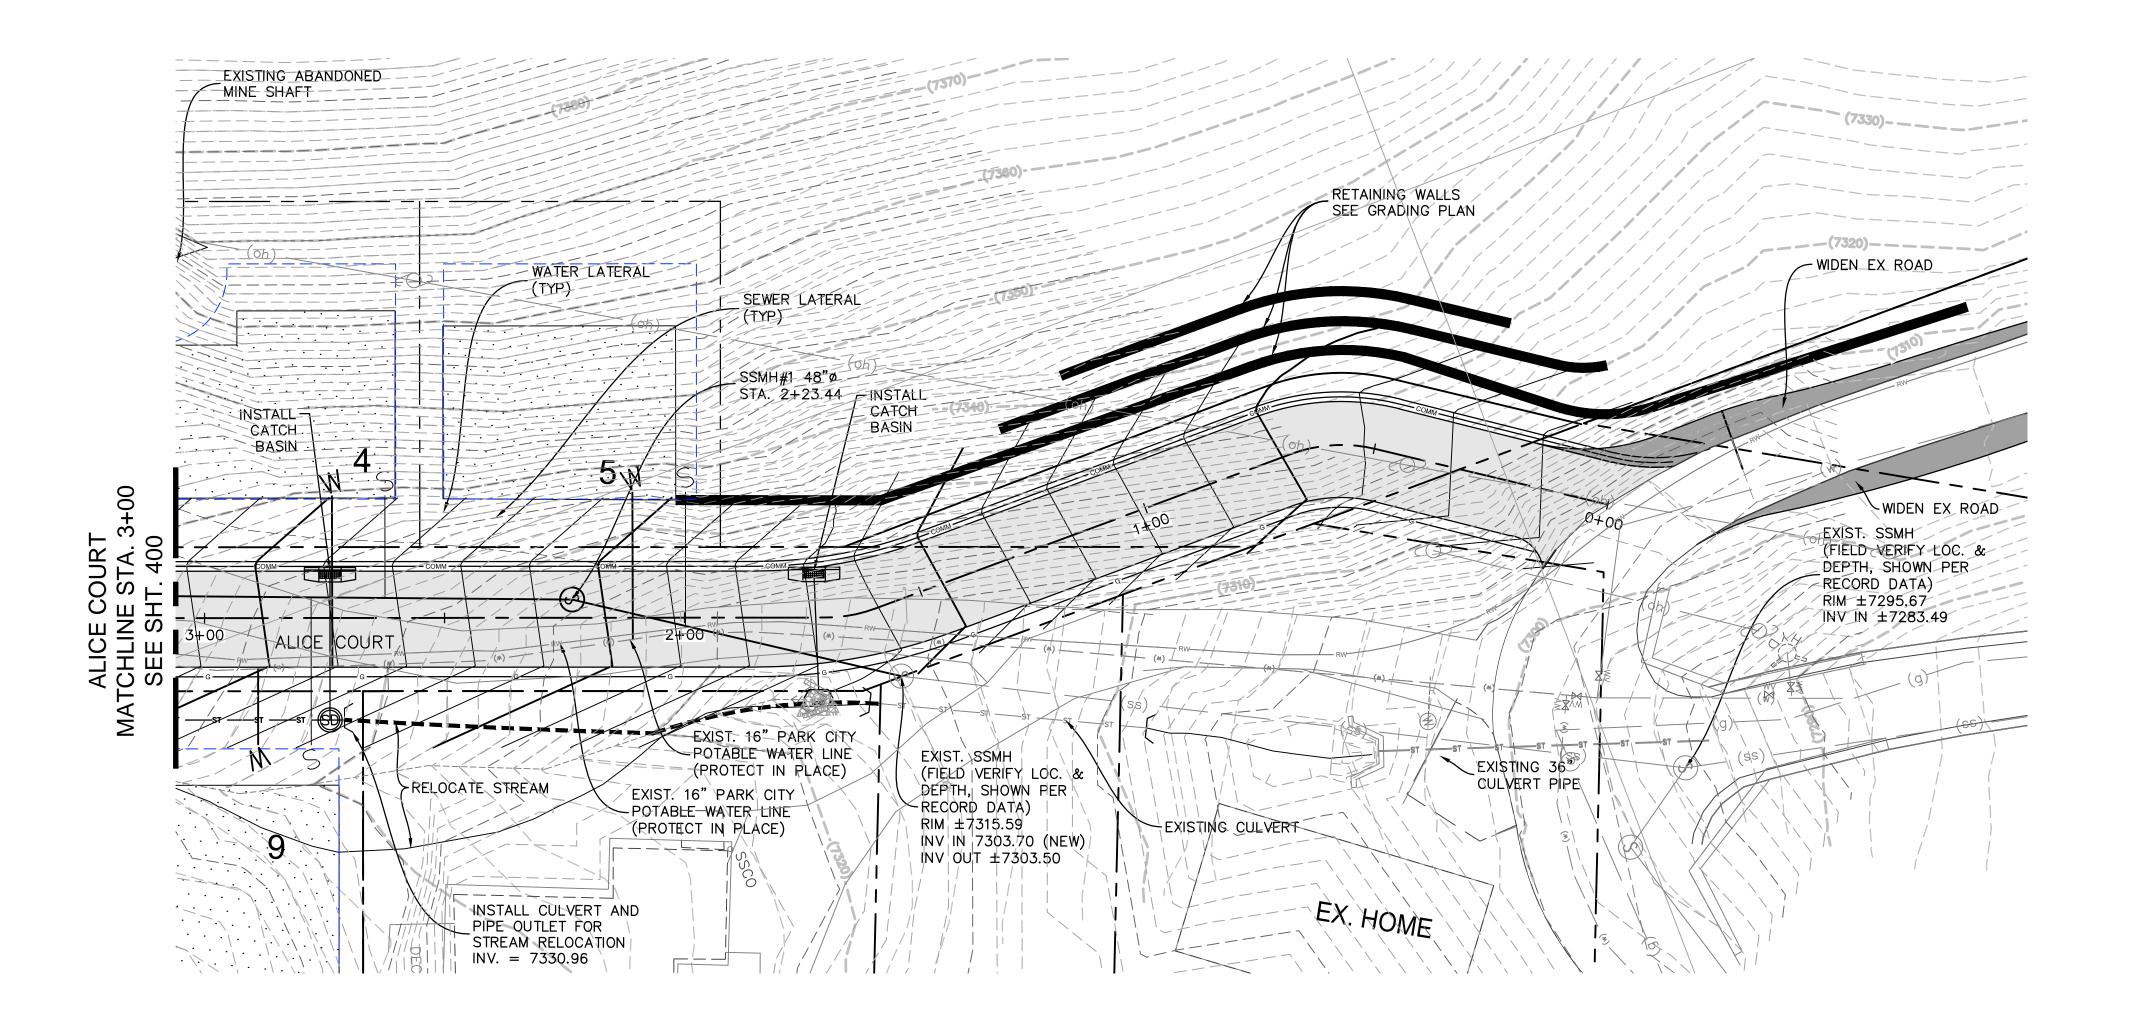

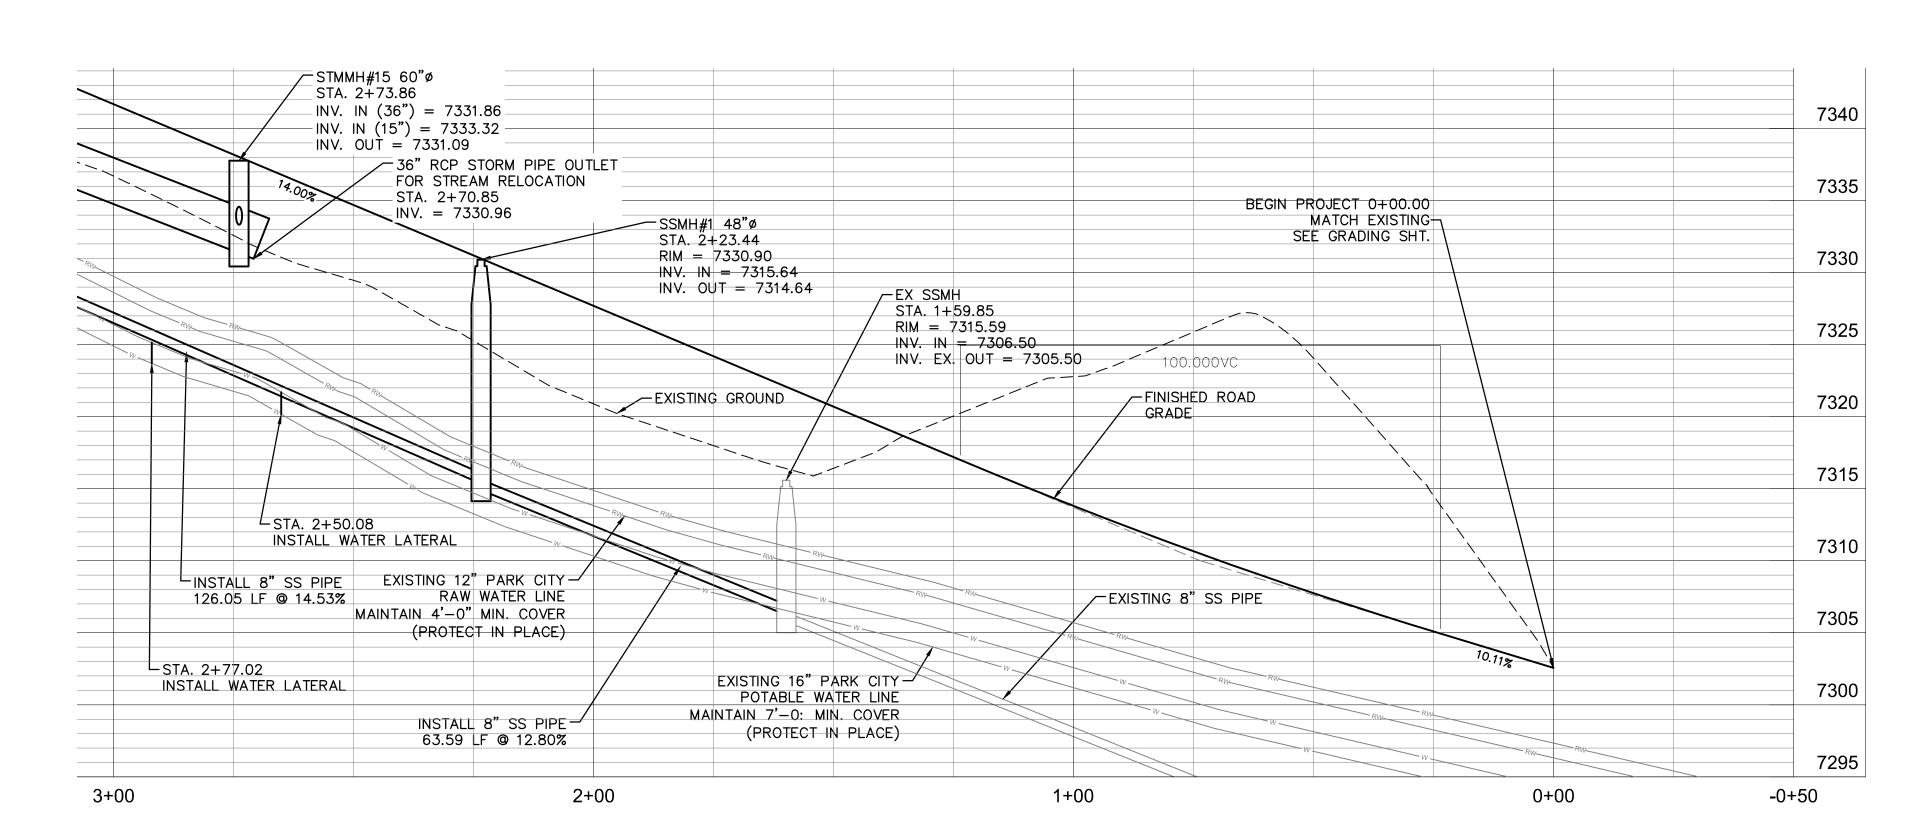





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Owner/Project

Legend

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ALICE CLAIM

Park City, Utah

ALICE GULCH PLAN AND PROFILE

Project No. 205303057	Scale 0 1"=20	20 40 60
Drawing No.	Sheet	Revision
C401	of	0

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ORIGINAL SHEET - ARCH D

1. CONTROLLING SEDIMENT TRANSPORT AND PREVENTING AND /OR CORRECTING PROBLEMS ASSOCIATED WITH EROSION AND RUNOFF PROCESSES THAT COULD OCCUR BOTH DURING AND INSPECTION OF SEDIMENT CONTROL DEVICES WILL BE SCHEDULED. PARTICULAR ATTENTION SHALL BE GIVEN TO EXISTING DRAINAGE PATTERNS THAT RUN THROUGH DISTURBED AREAS AND OVER EXTREME SLOPES. THESE PATTERNS WILL BE IDENTIFIED TO ISOLATE PROBLEM AREAS WHERE WATER WILL CONCENTRATE. PROVISIONS SHALL BE MADE TO CHANNEL RUNOFF AWAY FROM NEW OR EXISTING IMPROVEMENTS TO PREVENT UNDERMINING AND GENERAL SITE EROSION. THESE PROVISIONS SHALL BE STABILIZED AND SHALL REMAIN IN PLACE UNTIL THE PERMANENT STORM DRAINAGE FACILITIES ARE INSTALLED AND FUNCTIONAL.

2.EROSION CONTROL - A STORMWATER POLLUTION PRVENTION PLAN (SWPPP) WILL BE PROVIDED BY OTHERS IN ACCORDANCE WITH THE UTAH POLLUTANT DISCHARGE ELIMINATION WILL BE CONTROLLED. A NOTICE OF INTENT (NOI) WILL BE SUBMITTED BY OTHERS TO OBTAIN THE UPDES CONSTRUCTION PERMIT. A COPY OF THE PLAN MUST BE ON SITE AT ALL TIMES. THE CONTRACTOR'S RESPONSIBILITY TO TAKE CORRECTIVE ACTION AND REPAIR ANY DAMAGE CAUSED BY THE SILT OR EROSION IMMEDIATELY. ALL COSTS ASSOCIATED WITH THE MODIFICATION AND APPROVAL OF THE PLAN WILL BE THE RESPONSIBILITY OF THE CONTRACTOR.

3.BEFORE CONSTRUCTION BEGINS, THE LIMITS OF DISTURBANCE (LOD) BOUNDARY SHALL BE FLAGGED ON SITE AND APPROVED BY THE ENGINEER. UNDER NO CIRCUMSTANCES SHALL SITE DISTURBANCE OCCUR OUTSIDE THE DESIGNATED AREAS AT ANY TIME DURING CONSTRUCTION.

4.EXCAVATION AND EMBANKMENT OPERATIONS SHALL PROCEED IN SUCH A MANNER SO THAT FINISHING OF SLOPES, INCLUDING REVEGETATION SHALL BE ACCOMPLISHED AS SOON AS POSSIBLE AFTER ROUGH GRADING. ALL SLOPES 2:1 OR FLATTER SHALL BE SCARIFIED WITH HEAVY EQUIPMENT, LEAVING TRACKS PERPENDICULAR TO THE SLOPE.

5.CUT SLOPES SHALL BE 1:1 MAXIMUM AND FILL SLOPES 2:1 MAXIMUM UNLESS ROCK IS ENCOUNTERED OR RETAINING WALLS CONSTRUCTED. CUT SLOPES IN ROCK MAY BE STEEPENED, DEPENDING UPON GEOTECHNICAL CONSIDERATIONS. THE TOPS OF ALL CUT SLOPES IN ROCK MAY BE STEEPENED, DEPENDING UPON GEOTECHNICAL CONSIDERATIONS. THE TOPS OF ALL CUT SLOPES IN ROCK MAY BE STEEPENED, DEPENDING UPON GEOTECHNICAL CONSIDERATIONS. THE TOPS OF ALL CUT SLOPES IN ROCK MAY BE STEEPENED, DEPENDING UPON GEOTECHNICAL CONSIDERATIONS. THE TOPS OF ALL CUT SLOPES IN ROCK MAY BE STEEPENED, DEPENDING UPON GEOTECHNICAL CONSIDERATIONS. THE TOPS OF ALL CUT SLOPES IN ROCK MAY BE STEEPENED, DEPENDING UPON GEOTECHNICAL CONSIDERATIONS. THE TOPS OF ALL CUT SLOPES IN ROCK MAY BE STEEPENED, DEPENDING UPON GEOTECHNICAL CONSIDERATIONS. THE TOPS OF ALL CUT SLOPES IN ROCK MAY BE STEEPENED, DEPENDING UPON GEOTECHNICAL CONSIDERATIONS. THE TOPS OF ALL CUT SLOPES IN ROCK MAY BE STEEPENED, DEPENDING UPON GEOTECHNICAL CONSIDERATIONS. SLOPE ROUNDING SHALL OCCUR AS THE SLOPE IS BEING BROUGHT DOWN. THE OVERALL SHAPE, HEIGHT AND GRADE OF ANY CUT AND/OR FILL SLOPE SHALL BE DEVELOPED IN CONCERT WITH THE EXISTING NATURAL CONTOURS, SCALE AND VEGETATION OF NATURAL TERRAIN.

6.STABILIZATION PRACTICES MAY INCLUDE. BUT NOT BE LIMITED TO, TEMPORARY SEEDING, PERMANENT SEEDING, MULCHING, GEOTEXTILES, SOD STABILIZATION OF NATURAL VEGETATION AND OTHER APPROPRIATE MEASURES. USE OF IMPERVIOUS SURFACES FOR STABILIZATION SHALL BE AVOIDED. EXCEPT AS PROVIDED BELOW, STABILIZATION MEASURES SHALL BE INITIATED AS SOON AS POSSIBLE IN DISTURBED PORTIONS OF THE SITE WHERE CONSTRUCTION ACTIVITIES HAVE PERMANENTLY CEASED, BUT IN NO CASE MORE THAN 14 DAYS AFTER THE CONSTRUCTION ACTIVITY IN THAT PORTION OF THE SITE HAS TEMPORARILY OR PERMANENTLY CEASED.

A. WHERE DEEP SNOW OR FROZEN GROUND CONDITIONS PRECLUDE THE INITIATION OF STABILIZATION MEASURES BY THE 14TH DAY AFTER CONSTRUCTION ACTIVITY PERMANENTLY CEASES, STABILIZATION MEASURES SHALL BE INITIATED AS SOON AS PRECTICABLE.

B.WHERE CONSTRUCTION ACTIVITY ON A PORTION OF THE SITE IS TEMPORARILY CEASED. AND EARTH DISTURBING WILL RESUME WITHIN 21 WORKING DAYS. TEMPORARY STABILIZATION MEASURES NEED NOT BE INITIATED ON THAT PORTION OF THE SITE.

7.SPECIFICALLY OUTLINED DISTURBED AREAS, BOTH ON AND OFF-SITE SHALL BE REVEGETATED. THESE AREAS SHALL INCLUDE, BUT NOT BE LIMITED TO, ALL UNSURFACED AREAS, UNDERGROUND UTILITY CONSTRUCTION AREAS, BENCHED AREAS, INCLUDE RETAINING WALL BENCHES, AND TEMPORARY OR EXISTING ACCESS ROADS USED FOR CONSTRUCTION ACTIVITIES. CUT AND FILL SLOPES OVER 3:1 REQUIRE THE PLACEMENT OF EROSION CONTROL/REVEGETATION MATTING. SLOPES LESS THAN 3:1 MAY BE SPRAYED WITH TACKIFIER. ROCK CUTS STEEPER THAN 1:1 WILL NOT BE REVEGETATED.


8.SEDIMENT TRAPS MUST OUTLET ONTO STABILIZED (PREFERABLY UNDISTURBED) GROUND OR LEFT TO PERCOLATE INTO THE GROUND.

9.CONTROLLED OUTLETS SHALL DIRECT COLLECTED RUNOFF THROUGH SILT FENCES OR STRAW BALES

10. TYPICAL FUGITIVE DUST SHALL BE CONTROLLED BY WATERING AND/OR CHEMICAL STABILIZATION, PROVIDING VEGETATIVE OR SYNTHETIC COVER AND WIND BREAKS ARE CONSISTENT WITH THE UTAH STATE DIVISION OF AIR QUALITY STANDARDS.

11. ANY SEDIMENT TRACKED OFF-SITE SHALL BE REMOVED PRIOR TO THE END OF THE WORK SHIFT OR PRIOR TO SUNSET, WHICHEVER COMES FIRST.

12. CONTRACTOR MAY ADJUST THE LOCATIONS OF THE CONSTRUCTION FENCE, CONSTRUCTION TRAILERS, AND CONSTRUCTION MATERIALS RECEIVING ANS STORAGE AREAS, AS NEEDED TO ACCOMPLISH THE CONSTRUCTION. ALL CHANGES SHALL BE NOTATED ON THE EROSION CONTROL PLAN.

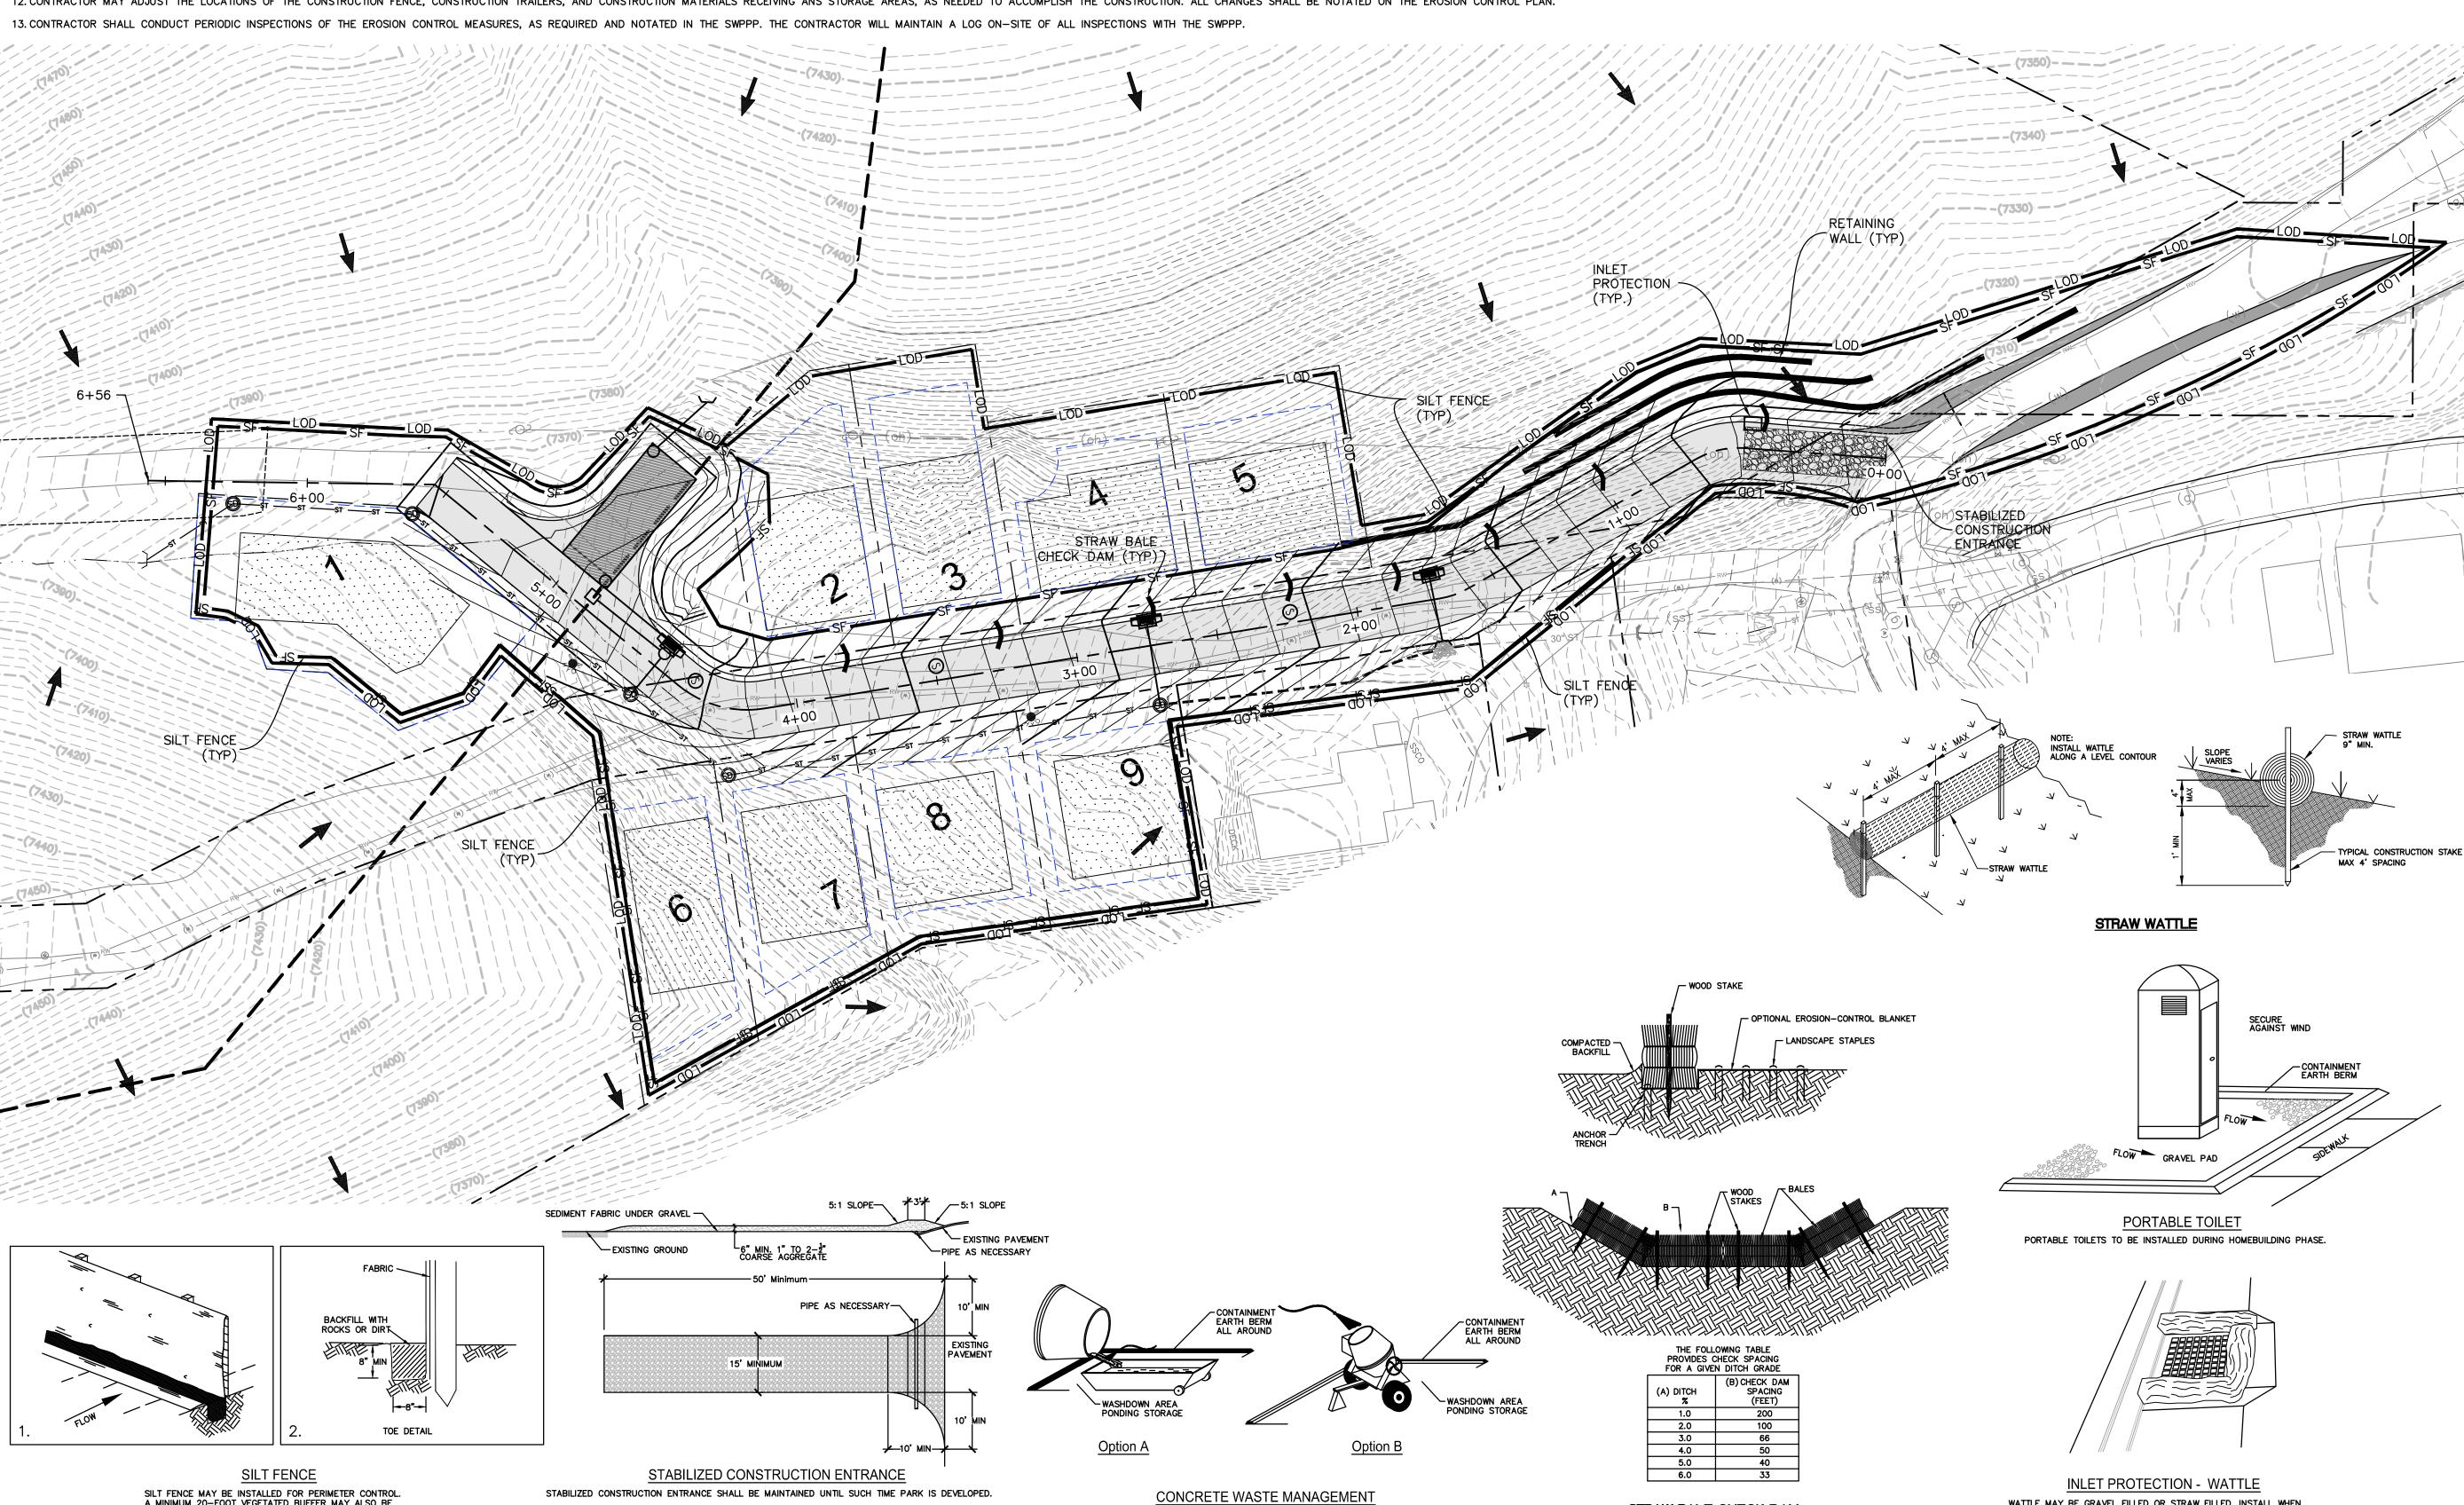






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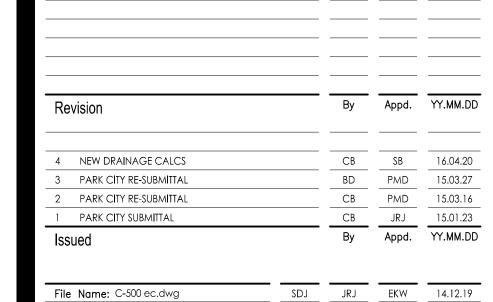
FLOW DIRECTION STABILIZED CONSTRUCTION ENTRANCE

> INLET PROTECTION STRAW BALE CHECK DAM


FINISH CONTOUR LINE

1. TEMPORARY RETAINING WALLS SHALL BE CONSTRUCTED ACROSS FUTURE DRIVEWAYS. FUTURE DRIVEWAYS AND FUTURE RETAINING WALLS N.I.C.

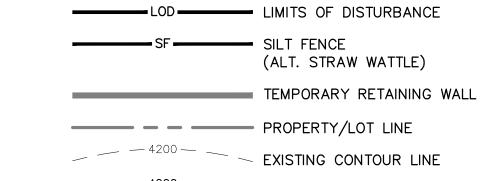2. ALL UTILITY WORK IS FUTURE AND SUBJECT TO REVIEW AND REVISION.



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Chkd.
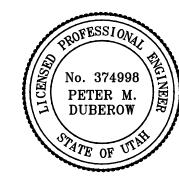
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WATTLE MAY BE GRAVEL FILLED OR STRAW FILLED. INSTALL WHEN

CONSTRUCTION OF CURB AND GUTTER AND ROADWAYS IS COMPLETE.

STRAW BALE CHECK DAM

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ALICE CLAIM Park City, Utah

EROSION CONTROL PLAN

Project No. 205303057	Scale 0 40'	60' 80'
Drawing No.	Sheet	Revision
C500	of	0

A MINIMUM 20-FOOT VEGETATED BUFFER MAY ALSO BE SUBSTITUTED FOR PERIMETER CONTROL

(PRESERVATION OF EXISTING VEGETATION).